


06/05/19

Luminaire Schedule						
Symbol	Qty	Label	Arrangement	Lum. Lumens	LLF	Description
	1	SA1	SINGLE	22816	0.910	McGraw Edison GLEON-AF-04-LED-E1-SL4-XX
	1	SA2	BACK-BACK	25291	0.910	McGraw Edison GLEON-AF-04-LED-E1-5WQ-XX
	2	SA3	SINGLE	24013	0.910	McGraw Edison GLEON-AF-04-LED-E1-SL3-XX
	2	T	SINGLE	3248	0.910	McGraw Edison TRR-50-LED-E1-5-XX
	10	W	SINGLE	9695	0.910	Lumark AXCL8A

Calculation Summary							
Label	CalcType	Units	Avg	Max	Min	Avg/Min	Max/Min
Paved - Grnd Lvl	Illuminance	Fc	3.3	15.3	0.2	16.35	76.50
Property Line - Ground Lvl	Illuminance	Fc	0.8	2.2	0.1	7.70	22.00

Luminaire Location Summary	
Label	Z
SA1	24.5 (30m BASE included)
SA2	24.5 (30m BASE included)
SA3	24.5 (30m BASE included)
T	14
W	14

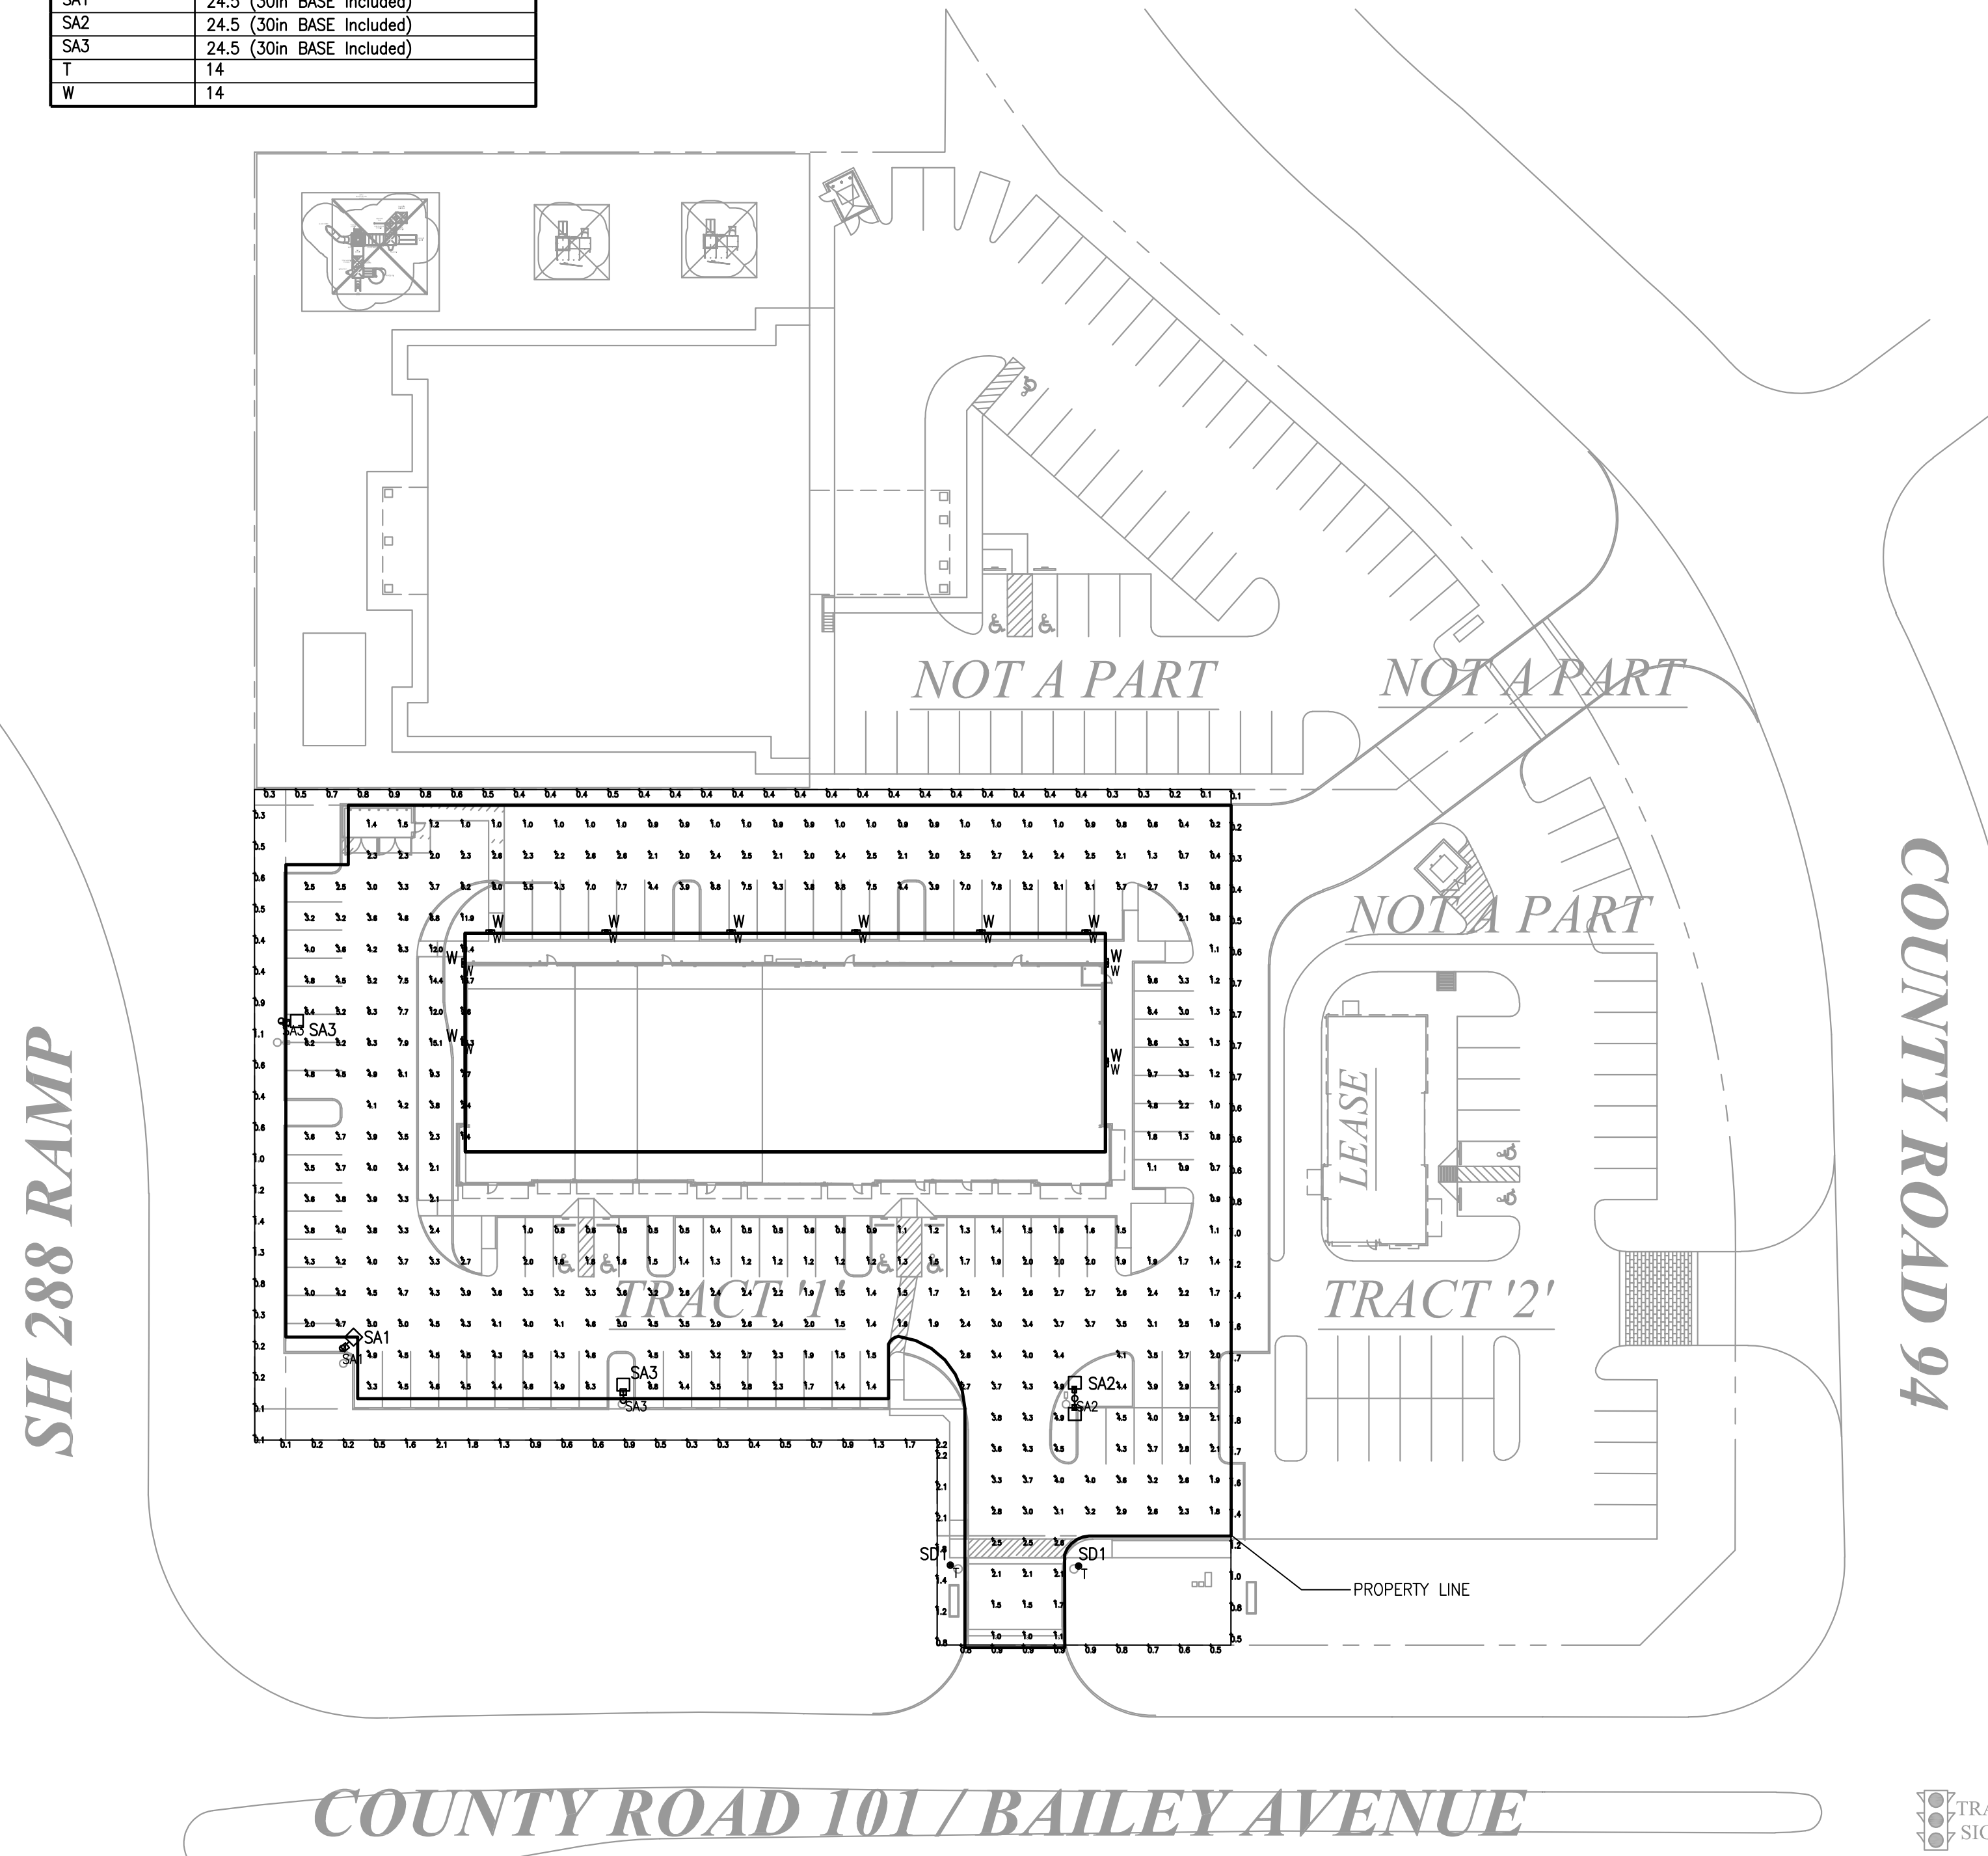

SALASO'BRIEN
[expect a difference]
10930 W. Sam Houston Parkway N., Suite 900
Houston, Texas 77064
281.664.1900 | Registration No. F-4111
Project No. 315-190083

ENGINEER SEAL & LOGO:

SEDONA LAKES

STATE HWY. 249
TOMBALL, TEXAS 77377

PROJECT NAME & LOCATION:

ISSUED FOR	DATE
BID	-
PERMIT	-
CONSTRUCTION	-

REVISIONS	
DATE	DESCRIPTION
06.05.19	FOR PERMIT

NORTH
1 ELECTRICAL PHOTOMETRIC SITE PLAN
SCALE: 1" = 40'-0"

PROJECT NO.
SHEET TITLE
ELECTRICAL PHOTOMETRIC SITE PLAN
SHEET NO.

E0.1

SHEET 2 OF 8